





This is an artistic representation of the design. It is not intended to be an exact rendition.

PROJECT:

PAHK RESIDENCE

LOCATION:

93 Raymond Ave Somerville, MA 02144

PREPARED BY:

Francis Harvey Remodeling, LLC 697 Hartford Turnpike Shrewsbury, MA. 01545

DATE:

2/7/2018

REVISION DATE:

Layout Page Table			
Label	Page Number		
Α	1	COVER PAGE	
Α	2	GENERAL NOTES	
Α	3	GENERAL NOTES	
Α	4	PLOT PLAN	
Α	5	DEMOLITION PLAN	
Α	6	EXISTING EXTERIOR ELEVATIONS	
Α	7	PROPOSED SECOND AND THIRD FLOOR PLANS	
Α	8	PROPOSED THIRD FLOOR PLAN	
Α	9	PROPOSED EXTERIOR ELEVATIONS	
Α	10	PROPOSED EXTERIOR ELEVATIONS	
Α	11	SCHEDULES AND ELECTRICAL LAYOUT	
Α	12	BATH INTERIOR ELEVATIONS	
Α	13	BEDROOM 3 INTERIOR ELEVATIONS	
Α	14	BEDROOM 4 INTERIOR ELEVATIONS	
Α	15	HVAC PLAN	
Α	16	STAIR DETAIL	
Α	17	CROSS SECTION	
Α	18	PRODUCT AWARENESS	
Α	19	PRODUCT AWARENESS	



アイエス

PROJECT

Caroline and Joon Pahk

93 Raymond Ave Somerville, MA 02144

CONTRACT PLANS		
APPROVED BY:		
APPROVED BY:		
DATE	REVISION DATE:	
· 2/7/2018		
	PRINTED ON:	
	5/31/2018	
COVER PAGE		

SCALE:	DRAWING #
	A
DRAWN BY:	
R.A.	1
N.S.	•
N.H.	

CERTIFIED PLOT PLAN




hs&t group, inc.

PROFESSIONAL CIVIL ENGINEERS & LAND SURVEYORS
75 HAMMOND STREET - 2ND FLOOR
WORCESTER, MASSACHUSETTS 01610-1723
PHONE: 508-757-4944 EMAIL: INFO@HSTGROUP.NET
FAX: 508-752-8895 WWW.HSTGROUP.NET

PROJECT: 93 RAYMOND AVE SOMERVILLE MA OWNER: CAROLINE PAHK

DATE: 02-02-18
ZONE: RA
SCALE: 1"=20'
COMP'D: DJT
CAD: DJT
FILE: RAYMOND93PL

I CERTIFY THAT THIS PLAN FULLY AND ACCURATELY DEPICTS THE LOCATION OF THE BUILDING AND DIMENSIONS AS SHOWN.

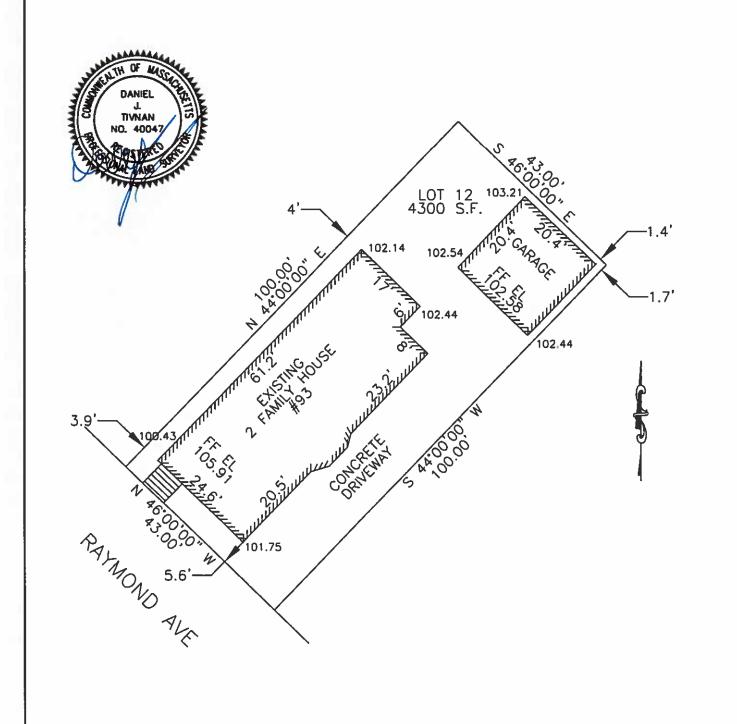

FAR CALCULATIONS

LOT AREA: 4,300.00 sq ft

BASEMENT: 290.00 sq ft 1st FLOOR: 1,139.38 sq ft 2nd FLOOR: 1,379.25 sq ft

2 1/2 FLOOR: 404.97 sq ft 3,213.60 sq ft

.7473

ALLOWABLE FAR: .75

FAR:

HEIGHT OF BUILDING

ELEVATION: 102.14

102.44 101.75 100.43 406.76

AVE GRADE: 101.69

MAX HEIGHT: 135.69



アイエ大

PROJECT

Caroline and Joon Pahk

93 Raymond Ave Somerville, MA 02144

CONTRACT PLANS

APPROVED BY:

APPROVED BY:

DATE

2/7/2018

REVISION DATE:

PRINTED ON:

5/16/2018

PLOT PLAN

SCALE: DRAWING #


DRAWN BY:


BY: R.A. N.S. N.H.



BUILDING HEIGHT ELEV: 133.48



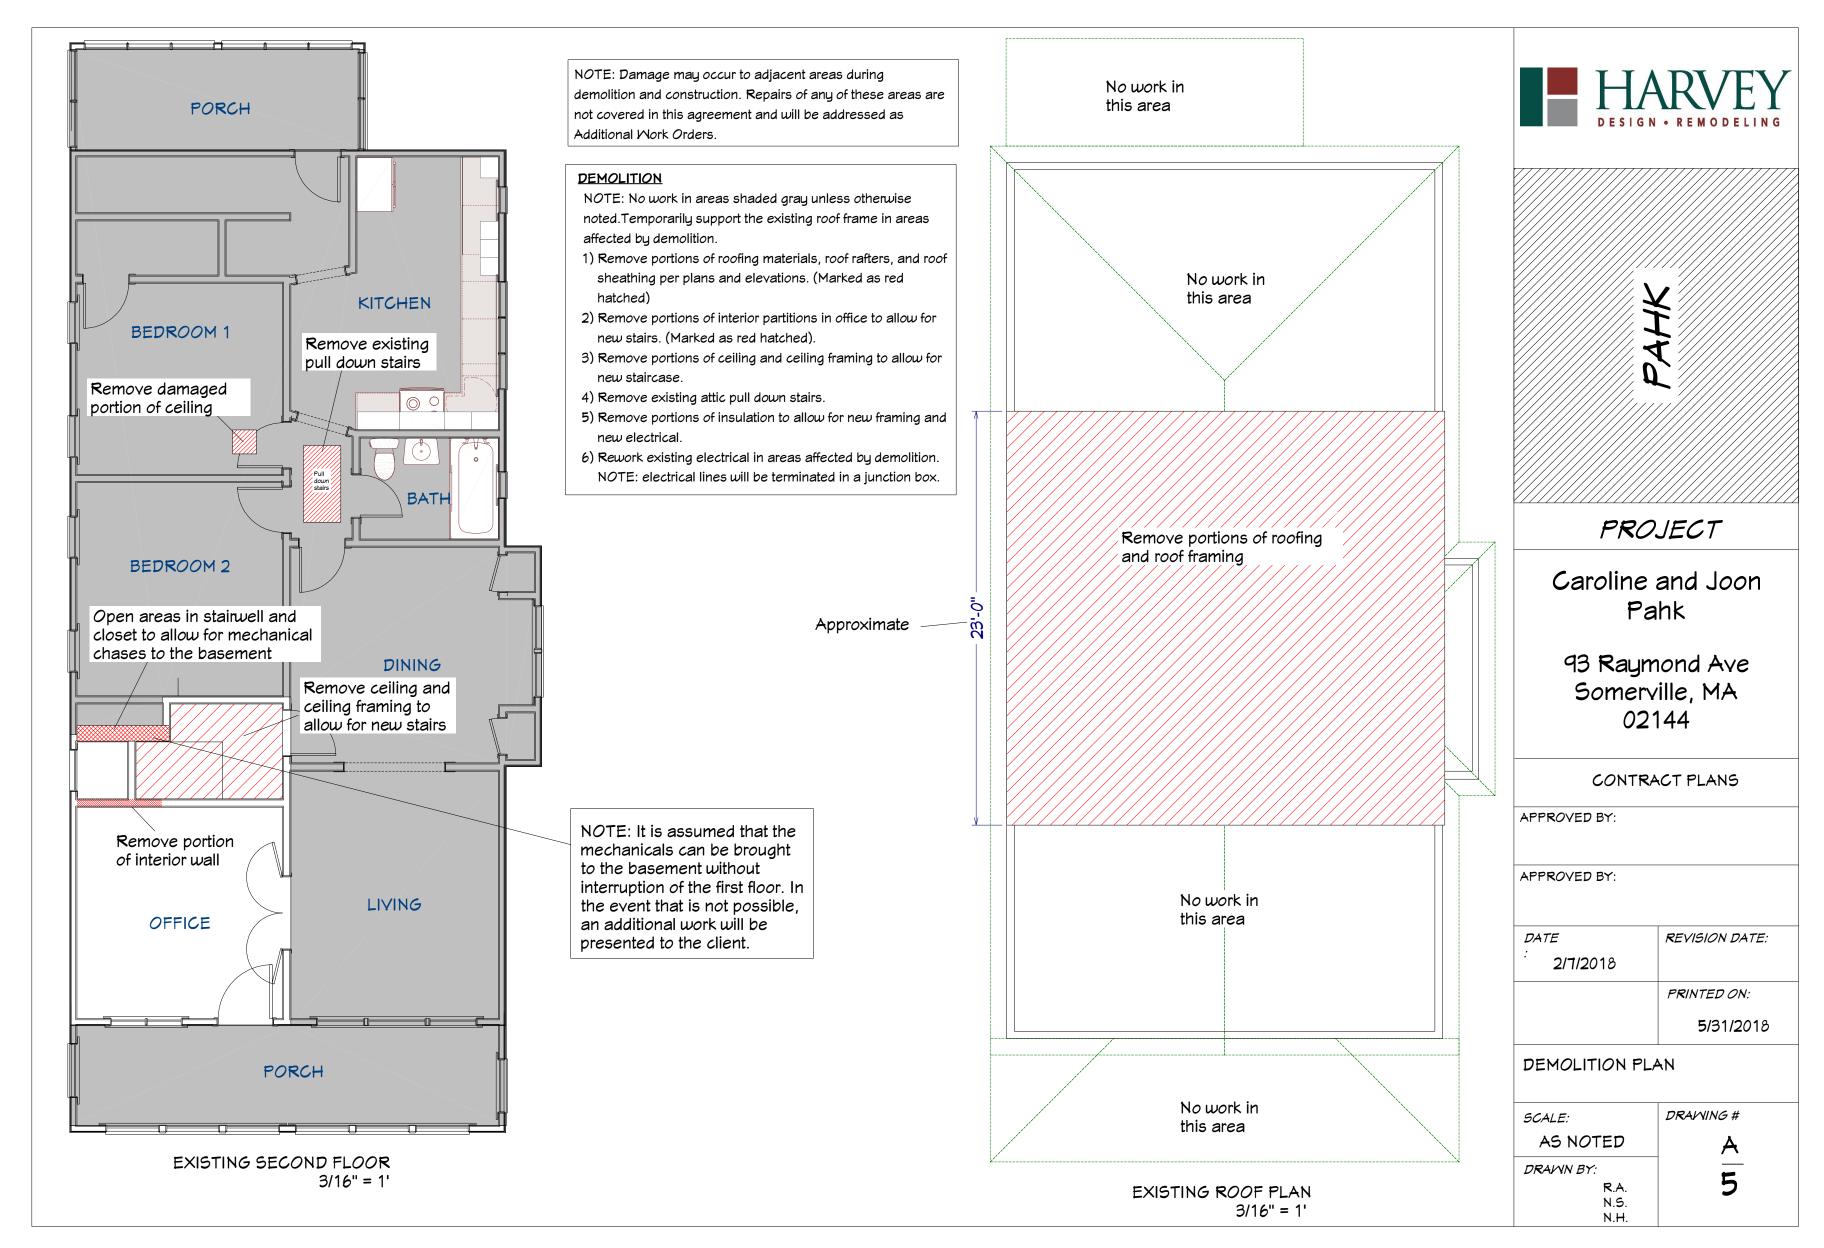

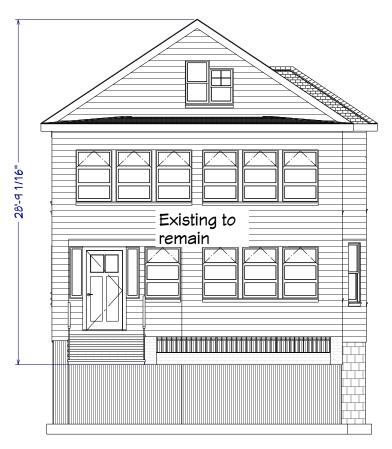


EXISTING FRONT ELEVATION 1/8" = 1'


Remove portions of roofing to allow for new over-frame



EXISTING REAR ELEVATION
1/8" = 1'

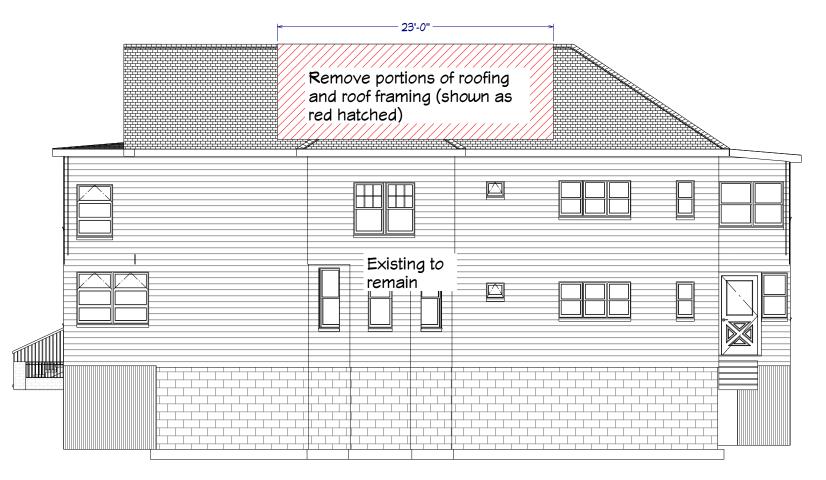

EXISTING RIGHT ELEVATION 1/8" = 1'

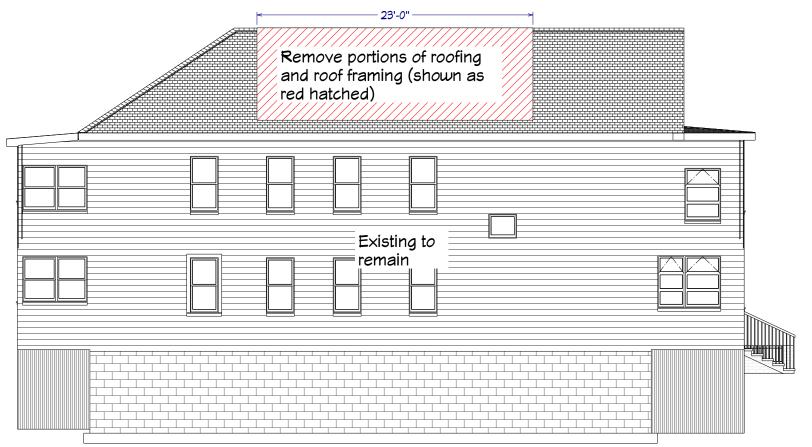


EXISTING LEFT ELEVATION
1/8" = 1'

	HARVEY DESIGN - REMODELING
	////// .
	////// L ////////
	//////. 4
	p_{\sim}
<u> </u>	<u> </u>
	PROJECT
C	aroline and Joon Pahk
c	13 Raymond Ave
	Somerville, MA
	02144
	CONTRACT PLANS

CONTRACT PLANS		
APPROVED BY:		
APPROVED BY:		
DATE	REVISION DATE:	
[:] 2/7/2018		
	PRINTED ON:	
	5 /31/ 2 018	
EXISTING EXTE	ERIOR	

GCALE:	DRAWING #
AS NOTED	A
DRAWN BY:	<u>_</u>
R.A. N.S.	6
NH	

ELEVATIONS

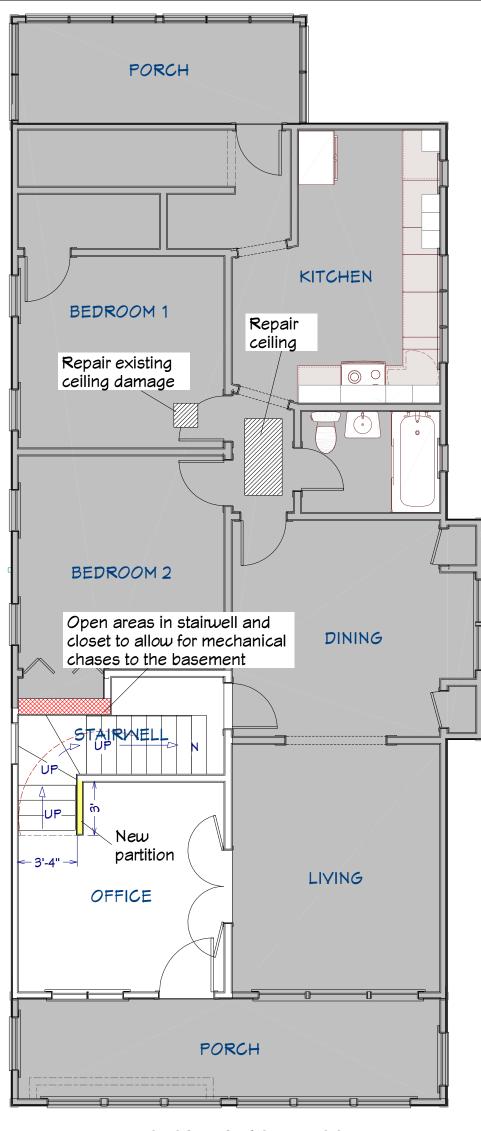

PROPOSED SECOND FLOOR 3/16" = 1'


CONSTRUCTION SCOPE

NOTE: No work in areas shaded gray unless otherwise noted.


- 1) Frame floor joists over existing ceiling joists per Framing plan and detail.
- 2) Install 3/4" T/G subfloor, glued and nailed with 8D ring shank nails in new spaces and in existing attic spaces.
- 3) Frame exterior walls with 2×6 wall construction, 1/2" sheathing, and Tyvek house wrap.
- 4) Frame roof per Roof Framing plan.
- 5) Install roof sheathing per framing plan.
- 6) Frame interior partitions per plans and wall types.
- 7) Frame new stairs from second floor to third floor per plans.
- 8) Frame in ceiling in area of old attic stairs.
- 9) Install new windows per plans and window schedule.
- 10) Install vinyl siding per plans and elevations. (Installed on new walls onlu)
- 11) Install EPDM roofing per plans and elevations. (Installed on new roof areas only)
- 12) Install electrical per plans and schedule.
- 13) Install new bath fan vent in new bath, vent to exterior.
- 14) Install plumbing feeds and drains to new bath fixtures. Tie into feeds and drains of the existing second floor unit.
- 15) Install new plumbing vents for new fixtures.
- 16) Install HVAC heat and air conditioning per HVAC plan and specifications page A-10
- 17) Insulate new walls with R-21 fiberglass batt insulation.
- 18) Insulate new ceiling with R-49 cellulose blown-in insulation.
- 19) Install 1/2" blue board and skim coat plaster to walls and ceilings. Walls will have a smooth finish. Ceilings and closet interiors will have a light textured finish.
- 20) Repair areas of existing ceilings per plans. NOTE: Repaired areas will be blended into existing textures and may not be an exact match
- 21) Repair areas of stairwell opened for mechanical chases to basement. NOTE: Repaired areas will be blended into existing textures and may not be an exact match.
- 22) Install treads, risers, skirts, and railing per Stair Detail page A-11
- 23) Install bathroom cabinets per plans and cabinet schedule.
- 24) Install counters per finish schedule.
- 25) Install bath fixtures per plans and finish schedule.
- 26) Install doors per plans and schedule.
- 27) Install primed 1 X 6 window and door header trim with Brosco B100 vertical trim to be similar to photo on A-9.
- 28) Install primed Brosco baseboard moulding B400 FJP.
- 29) Install one melamine closet shelf and one pole in new bedroom closets.
- 30) Install 2 1/4" oak plank flooring, sand and finish with three coats of oil finish.
- 31) Paint new walls with one primer coat and two finish coats.
- 32) Paint new ceilings with one primer coat and one finish coat.
- 33) Paint pre-primed trim two finish coats.
- 34) Paint doors with two finish coats.

EXISTING SECOND FLOOR PAINTING SCOPE

- 1) Paint ceiling with one primer coat and one finish coat in Bedroom 1, Hall, Stairwell, and Office.
- 2) Paint walls in Office and Stairwell (new and existing) with two finish coats, newly plastered areas will be primed with one coat.
- 3) Paint Office and new Stairwell trim with two finish coats.

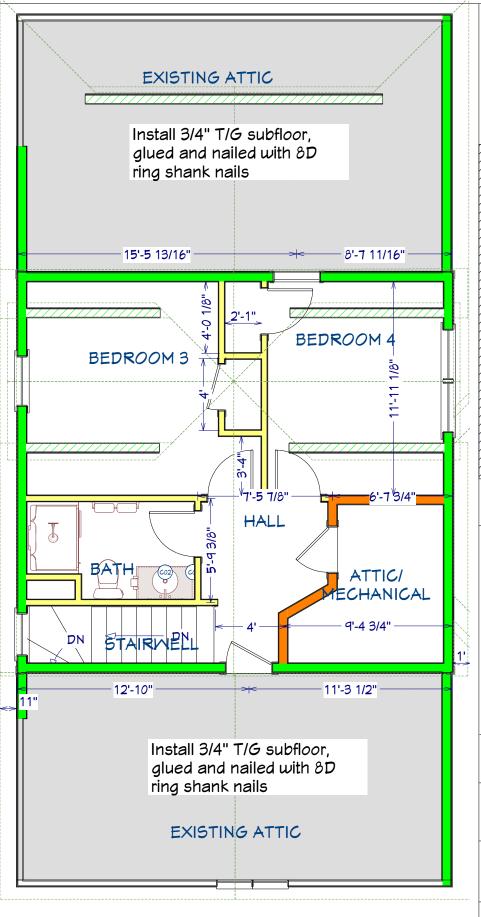

PROPOSED THIRD FLOOR 3/16" = 1'

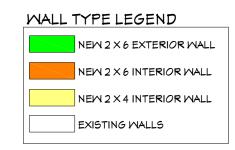



PROJECT

Caroline and Joon Pahk

93 Raymond Ave Somerville, MA 02144

CONT	RACT	PLANS
CONT		

APPROVED BY:

APPROVED BY:

DATE REVISION DATE:

PRINTED ON:

5/31/2018

PROPOSED SECOND AND THIRD FLOOR PLANS

SCALE:


AS NOTED


DRAWN BY:


R.A.

N.S.

N H

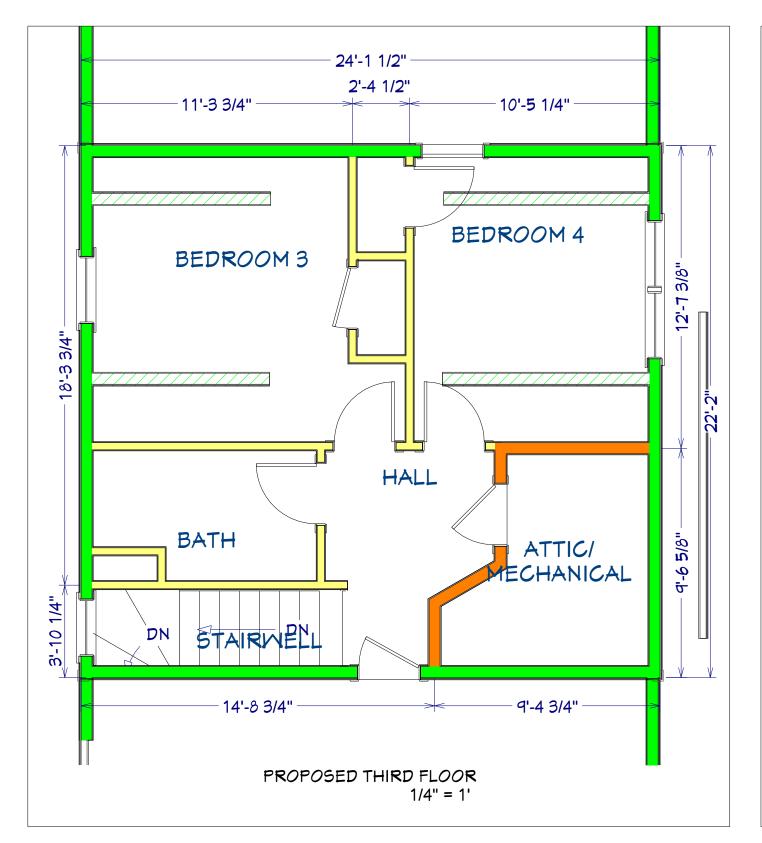

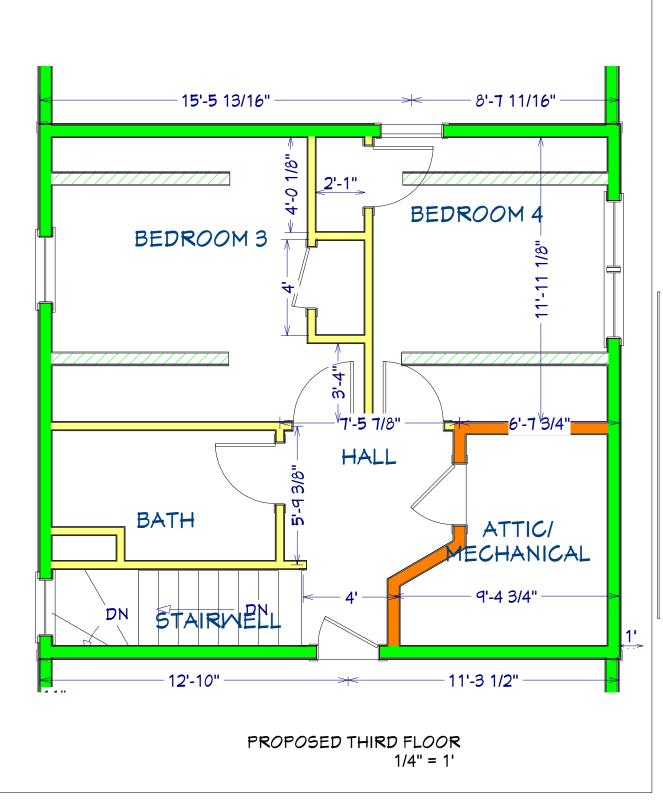

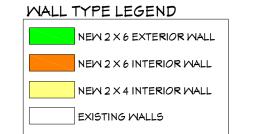



りを打が

PROJECT

Caroline and Joon Pahk

93 Raymond Ave Somerville, MA 02144

CONTRACT PLANS

APPROVED BY:

APPROVED BY:

DATE REVISION DATE:

PRINTED ON:

5/31/2018

PROPOSED THIRD FLOOR PLAN

SCALE:

AS NOTED

DRAWN BY:

R.A.

N.S.



アタゴズ

PROJECT

Caroline and Joon Pahk

93 Raymond Ave Somerville, MA 02144

CONTRACT PLANS	

APPROVED BY:

APPROVED BY:

DATE REVISION DATE:

PRINTED ON:

5/31/2018

PROPOSED EXTERIOR ELEVATIONS


DRAWING #
A
D

N.S. N.H.

DRAWN BY: R.A.

9

Aluminum wrapped rake trim

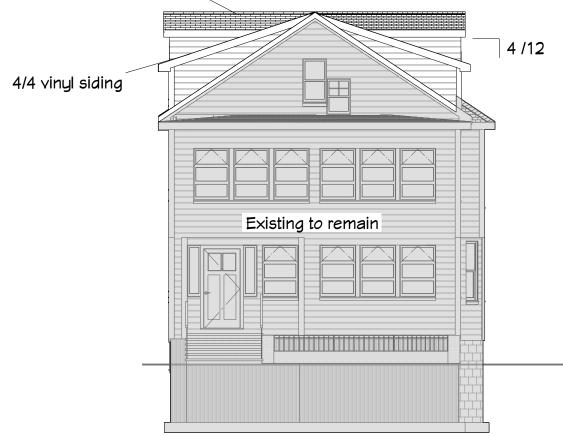


PROPOSED FRONT ELEVATION 1/8" = 1'


Aluminum wrapped rake trim Gable end of roof over-frame 4/4 vinyl siding Install new A/C condenser. Connect to the new HYAC system on the third floor.


PROPOSED REAR ELEVATION 1/8" = 1'

VINLY SIDING (New framing only)

- 1) Install house wrap over wall sheathing with taped seams. Wrap into window openings and tape over window flanges.
- 2) Install 3 1/3" vinyl outside corners, color to be "Autumn Yellow" or approved equal.
- 3) Install double 4" Certainteed Mainstreet vinyl siding, Color to be "Autumn Yellow" or approved equal.
- 4) Install vented T-4 vented vinyl soffit panels.
- 5) Wrap fascias and rakes with aluminum coil.

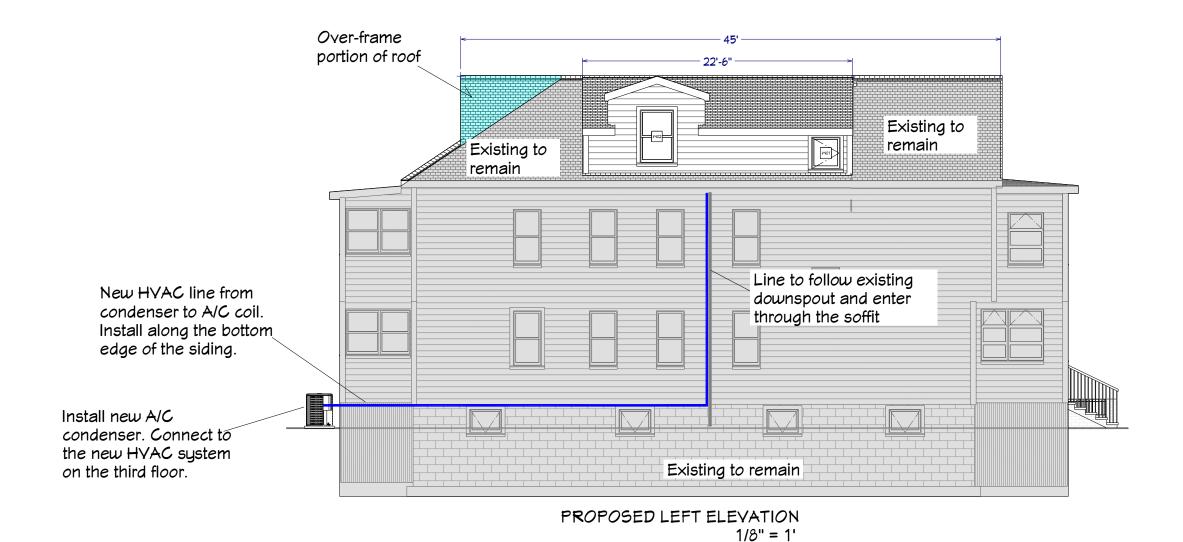

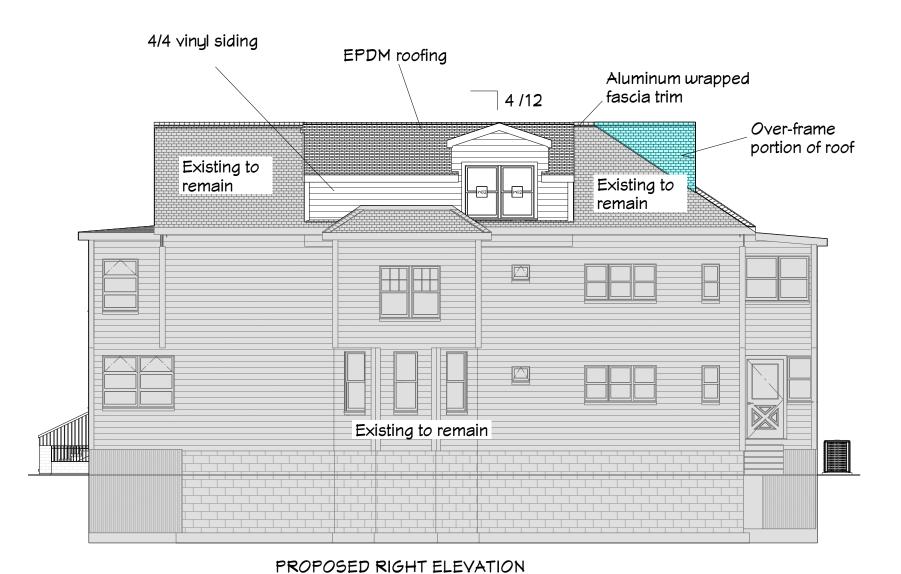

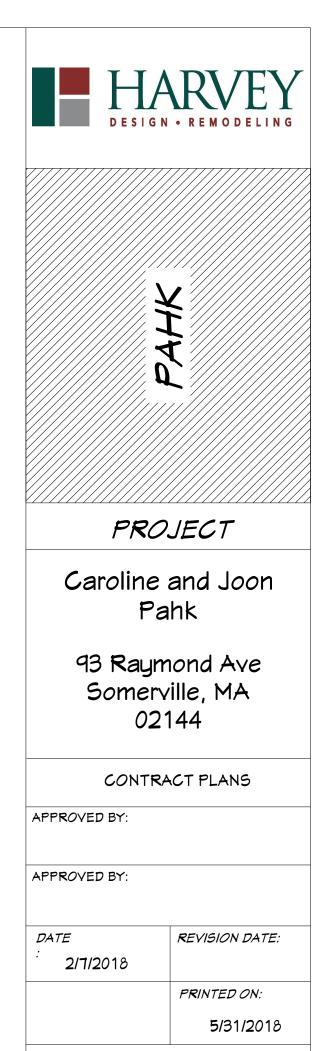

	PRINTE.
	5/3
PROPOSED EXT	ERIOR
SCALE:	DRAWIN

N.S.

N.H.

SCALE:	DRAWING #
AS NOTED	A
DRAWN BY:	
R.A.	1 (

1/8" = 1'